# Roof Replacement for Valdosta Early College Academy 1605 Azalea Drive, Valdosta GA 31602 Valdosta City School System

### ARCHITECTURAL

ALTMAN + BARRETT ARCHITECTS P.C.

117 WEST MAIN STREET
HAHIRA, GEORGIA 31632
(229) 585-9018

### ELECTRICAL

ELECTRICAL DESIGN CONSULTANTS, INC.
1201 BROAD STREET, SUITE 1A
AUGUSTA, GEORGIA 30901
(706) 724-3551

## LOCATION MAP



# INDEX TO DRAWINGS

GENERAL

X1000 COVER SHEET AND DRAWING INDEX

ARCHITECTURAL


A1000 ROOF PLAN - DEMOLITION AND NEW ROOF

A1001 EXISTING PHOTOS
A3100 DETAILS


ELECTRICAL

E0001 LEGEND, NOTES, ELECTRICAL COMPOSITE AND DEMO PLAN

E1001 ELECTRICAL PLAN

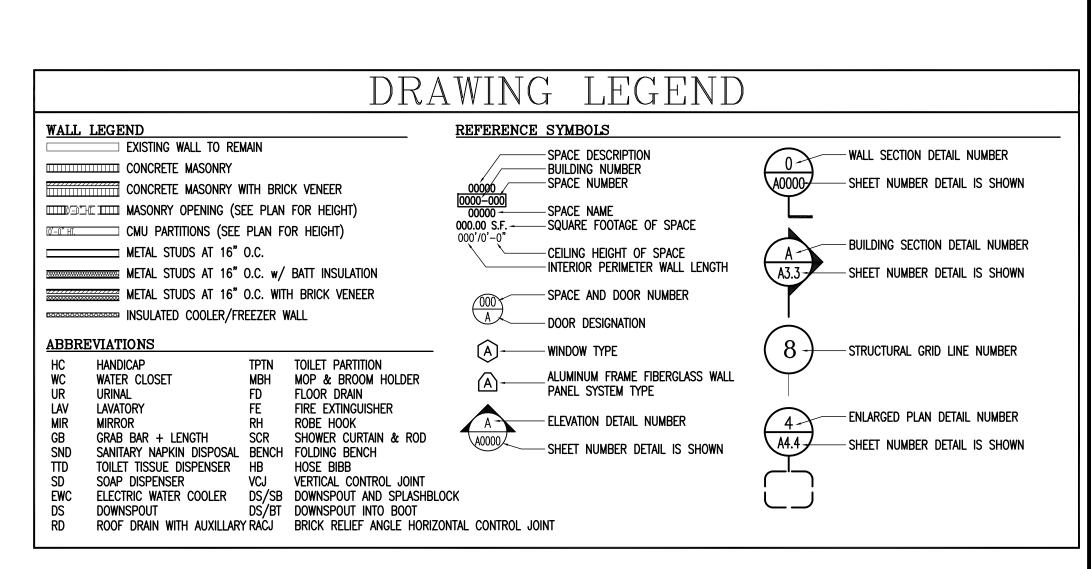

<u>Altman + Barrett</u>

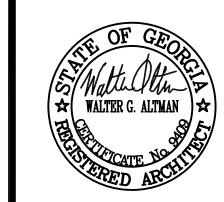



ST. ST.

+ Barret

r c h i t
BOX 665 - 117
HAHIRA, ĢEORG

DATE: Nov. 16, 2019

DRAWN: T. Petitjean

CHECKED: W. Altman

REVISIONS: 1.


of Replacement for Early College Academy a Drive, Valdosta GA 3160

1605 1605

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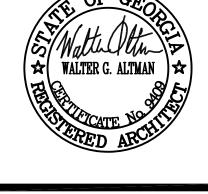
PROJECT NO: 19032

Triday Navarahar 15 20




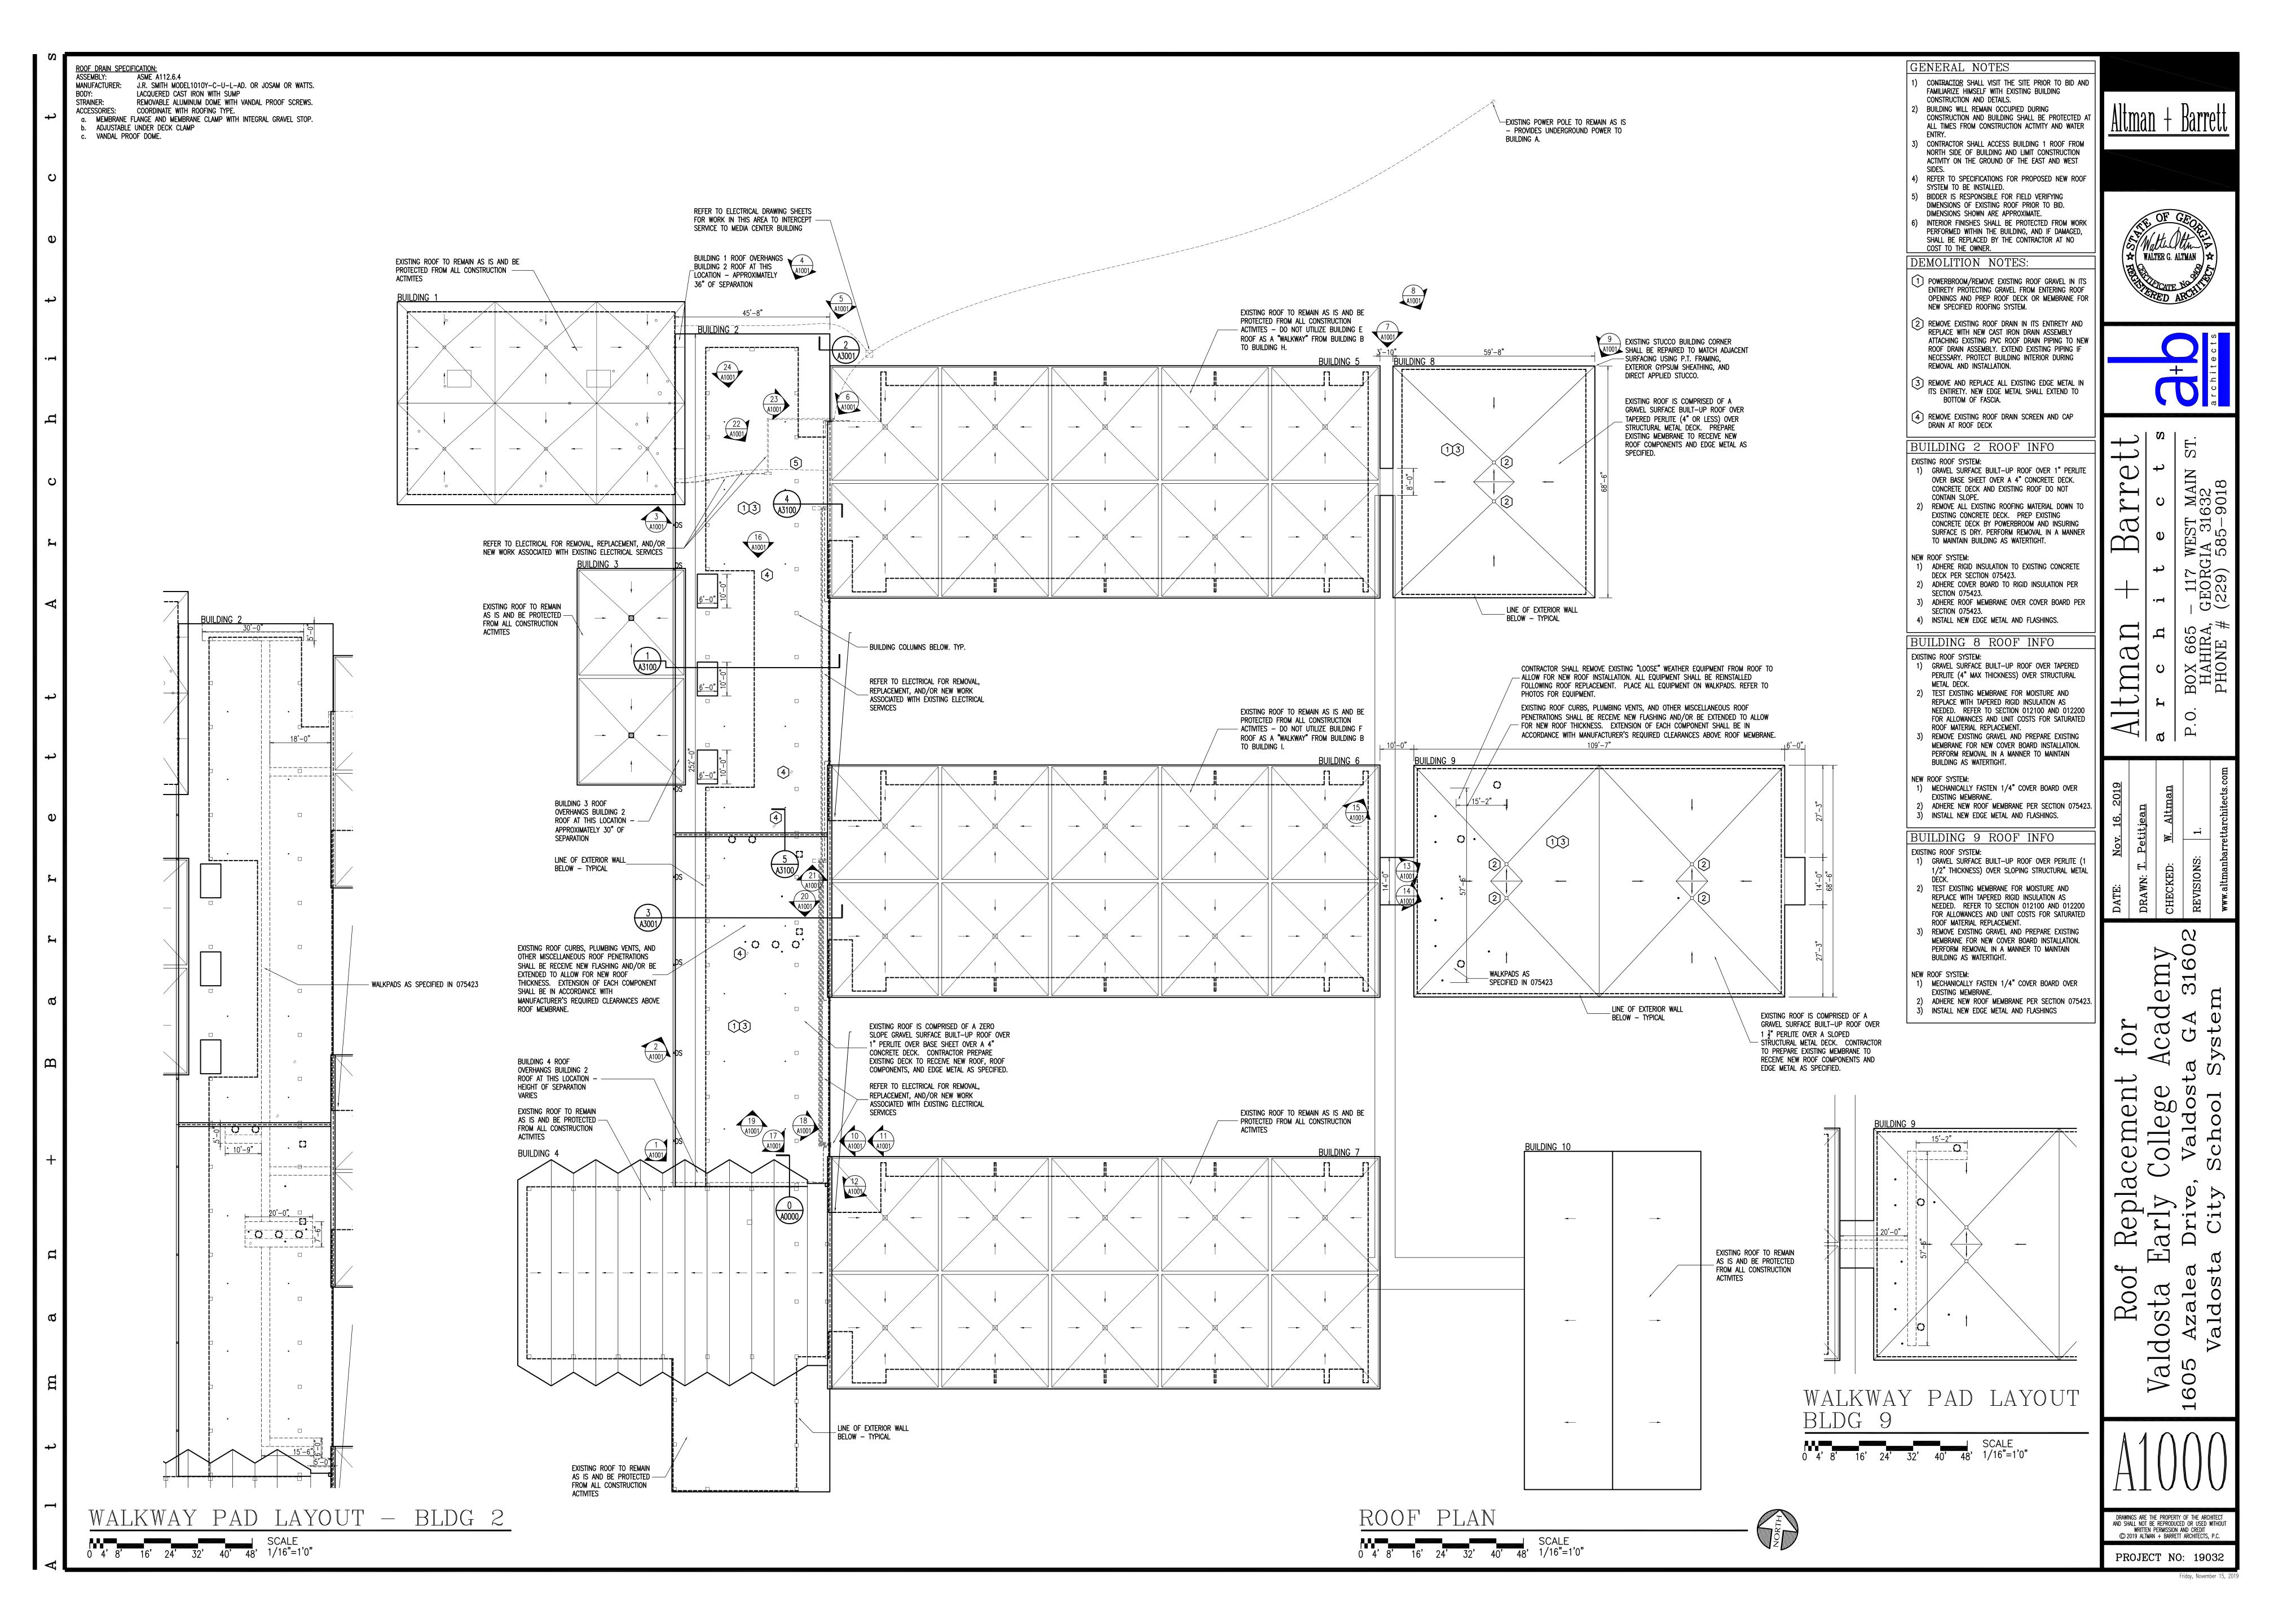





PROJECT NO: 19032

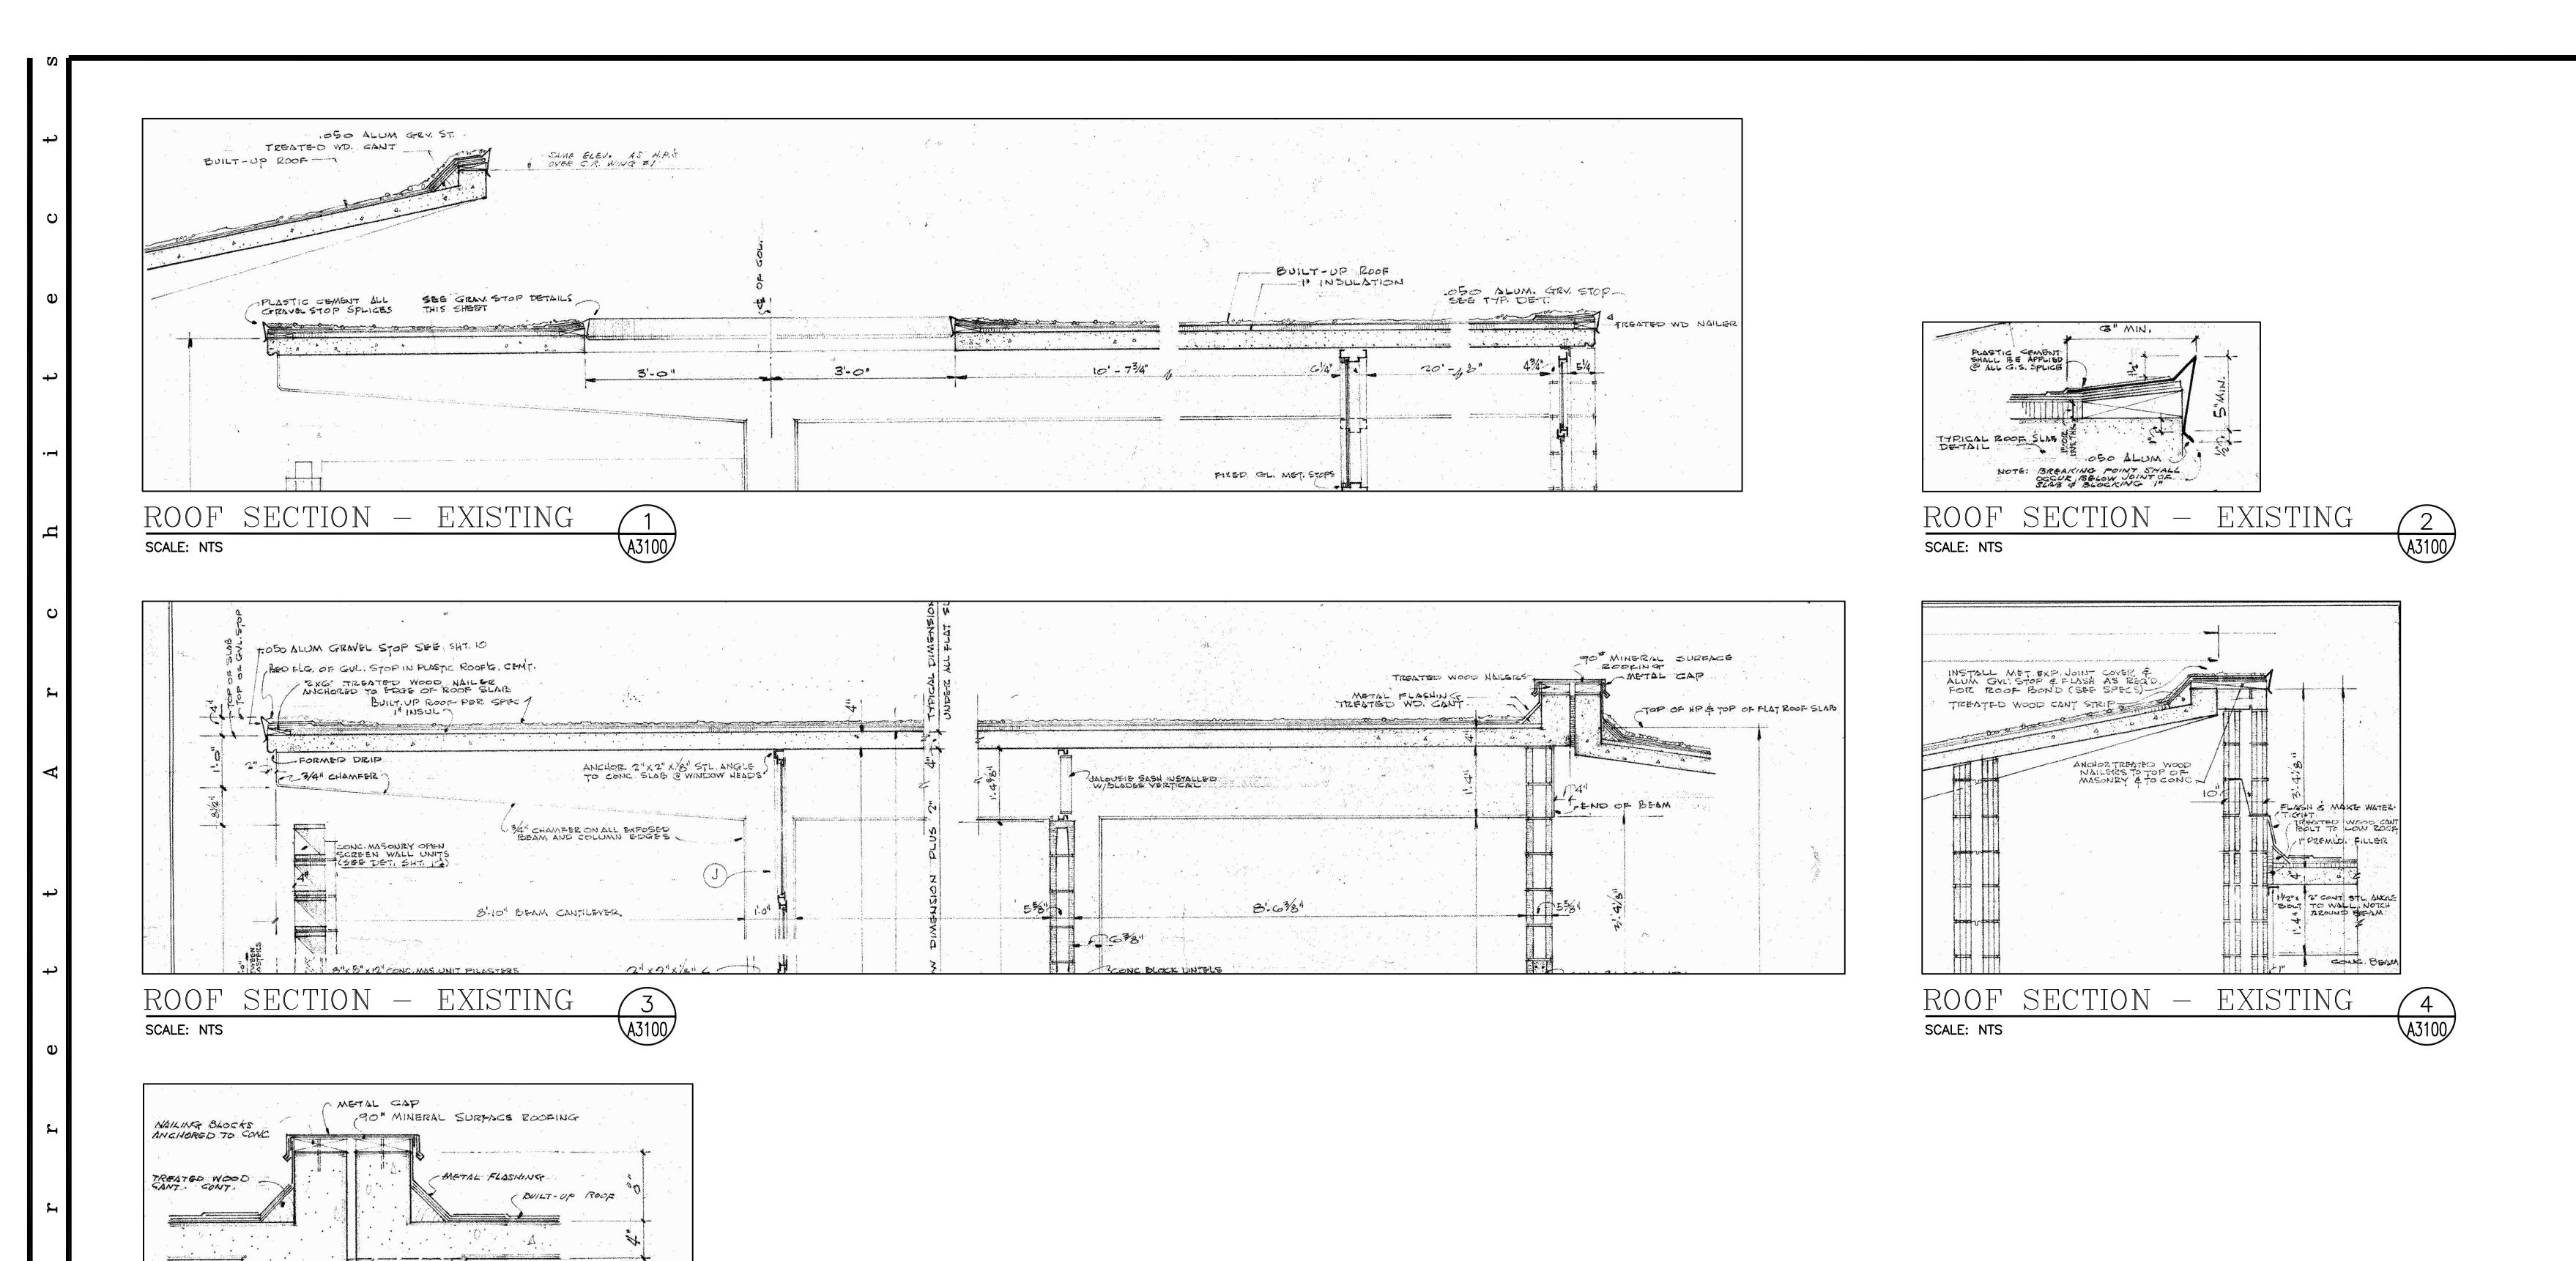

6 A3100

SLAB WHERE BEAM DOES NOT OCCUR W/ 2/2" X 21/2" ANGLE

PLATE CONTE ON EXTERIOR STURE INTERIOR - ATTACH TO ONE SIDE OF

EXISTING

YOINT ONLY.

PREMLO. EXP. STRIP!

SCALE: NTS

SECTION

SEE STRUCTURAL DWGS.


A3100

TO LOW BY OULY

ROOF SECTION - EXISTING

SCALE: NTS

-Z'XZ" ALOM X

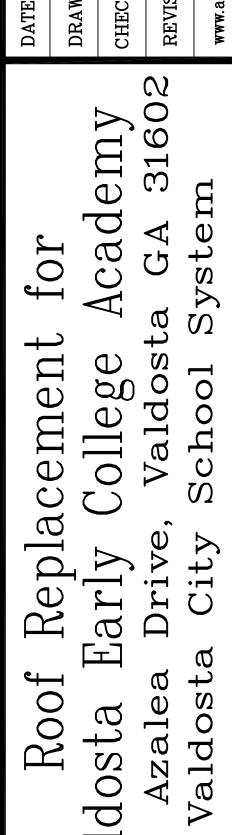

Barre

Altm

P.0.


A3100

Val 05

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PROJECT NO: 19032


Triday Nayambar 15

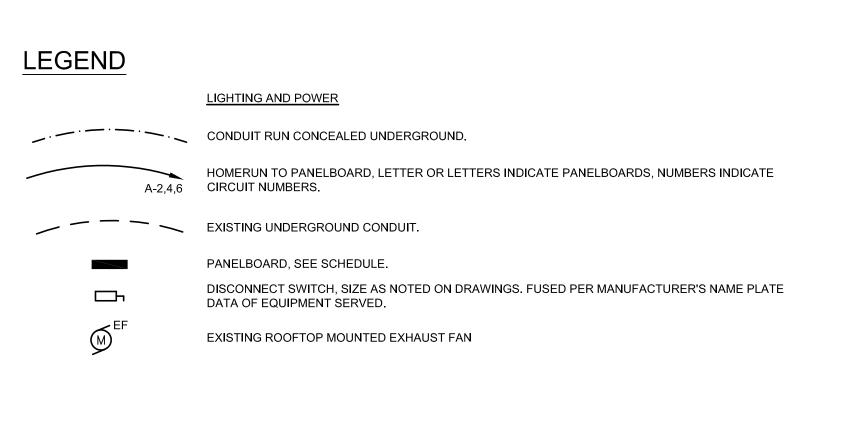

VOLTAGE <u>120/208</u>		Г	¬ ^	NIF	- 1					LOCATIONEXTERIOR
PHASE 3 WIRE 4	PANELnm								MOUNTING SURFACE	
			МА	IN AI	/IPS	200				MAIN LUGS ONLY
SERVING		BREAKER		CKT		СКТ	BF	REAKER		SERVING
	VA	AMPS	Р	NO.		NO.	Р	AMPS	VA	SERVING
EXISTING COND. UNIT	_	30	2	1	<u> </u>	2	2	30	_	EXISTING COND. UNIT
				3	-	4				
EXISTING COND. UNIT	_	30	2	5	-	6	2	40	_	EXISTING AHU
				7		8				
EXISTING AHU		40	2	9		10	2	40	_	EXISTING AHU
				11		12				
SPARE		30	2	13	+	14	1	20	_	EXISTING LOAD
				15		16	1	20	_	EXISTING LOAD
SPARE		40	2	17	<del>                                     </del>	18	1	20	_	EXISTING LOAD
				19		20	1	20	_	SPARE
SPARE		30	2	21		22	1	20	_	SPARE
				23	-	24	1	20	_	SPARE
REMARKS: NEMA 3R										

#### **GENERAL NOTES:**

- 1. FIELD COORDINATE ROUTING AS REQUIRED FOR EXISTING CONDITIONS.
- 2. COORDINATE REMOVAL OF EXISTING FEEDERS/CIRCUITS AND INSTALLATION OF NEW WORK AS REQUIRED TO MINIMIZE DOWNTIME. COORDINATE WITH ROOFING CONTRACTOR, ARCHITECT, AND OWNER.
- 3. ALL EXPOSED CONDUIT ON EXTERIOR OF BUILDING SHALL BE GALVANIZED RIGID STEEL. PAINT CONDUIT TO MARCH BUILDING EXTERIOR.

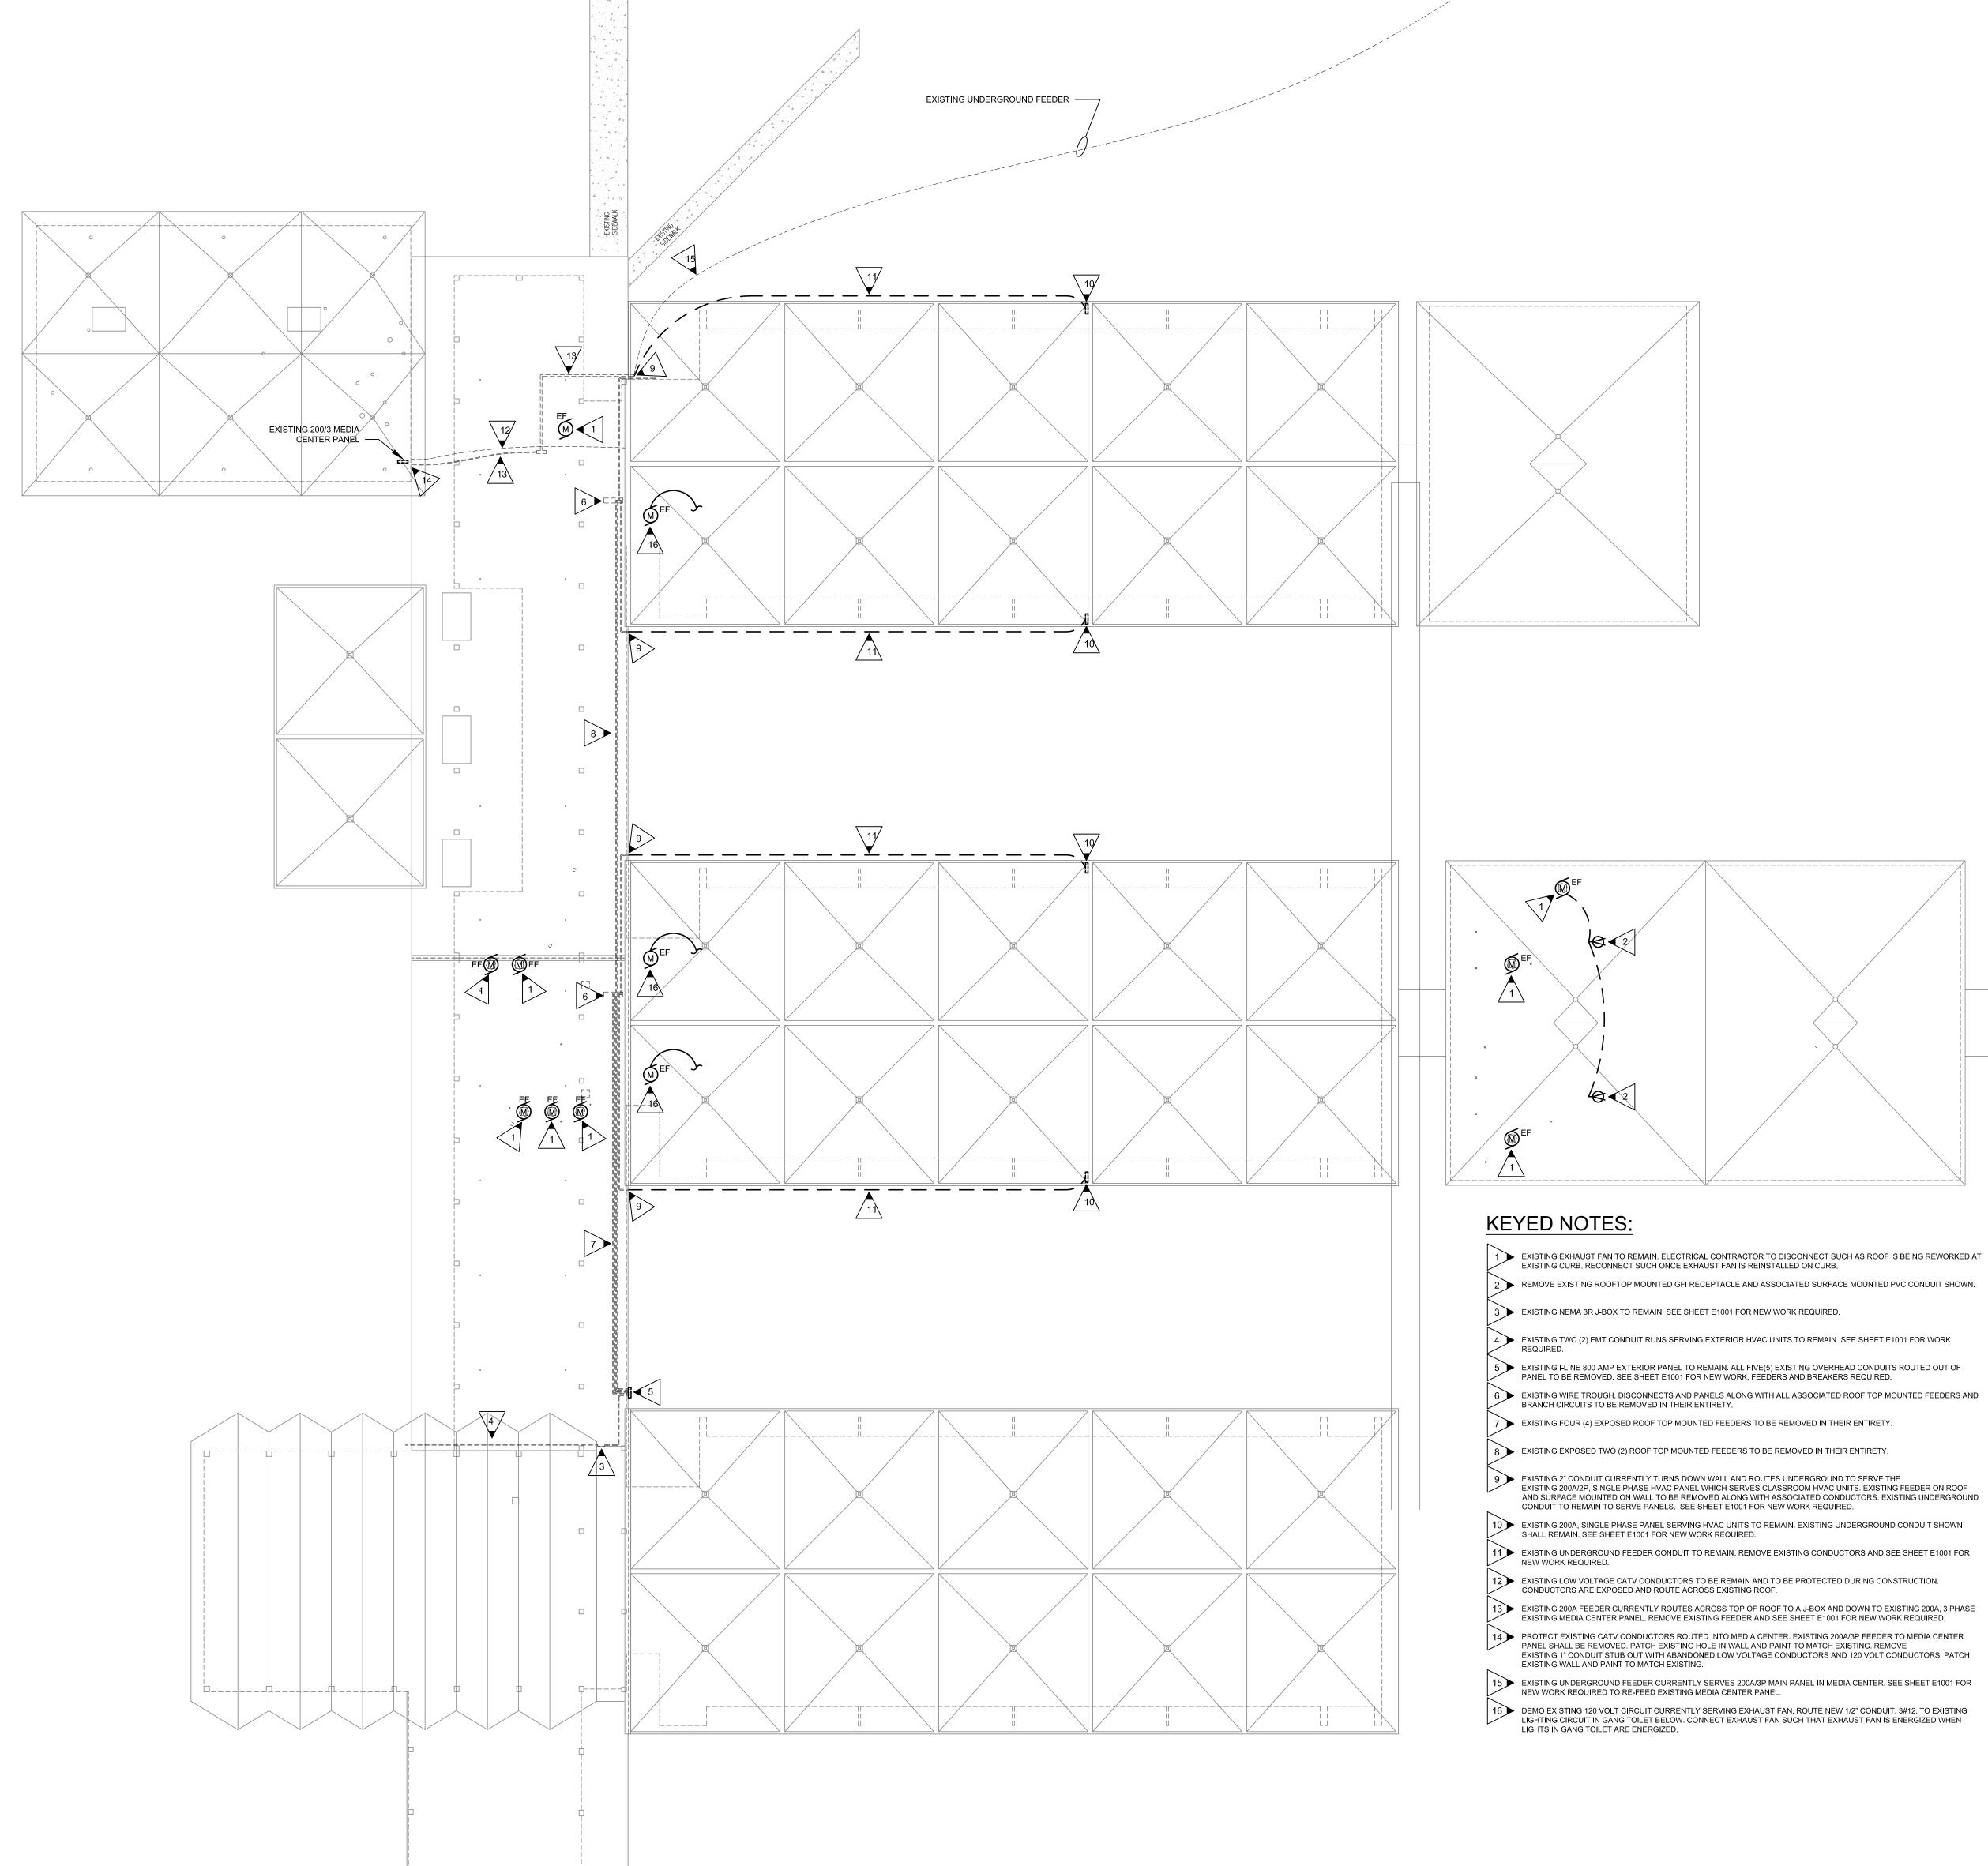





r c h i t e c t s

c h i t e c t

OX 665 - 117 WEST MAIN S

IAHIRA, GEORGIA 31632

a r c h i t

P.0. BOX 665 - 117 HAHIRA, ĢEORG

DRAWN: <u>JEF</u>

CHECKED: <u>MAP III</u>

REVISIONS:

of Replacement for Early College Academy sa Drive, Valdosta GA 3160

H0001

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PROJECT NO: 19032

ELECTRICAL DESIGN ELECTRICAL ENGINEERS

1201 BROAD ST., SUITE 1-A AUGUSTA, GA 30901 PH: (706) 724-3551 FAX: (706) 724-8507 CONSULTANTS, INC. EDC PROJECT #: 19153

1 ELECTRICAL COMPOSITE AND DEMOLITION PLAN
E0001 SCALE: 1/16"=1'-0"

